

14818 N. 74TH STREET SCOTTSDALE, ARIZONA 85260

OWNER

TRIPLE C AIRPARK PROPERTIES LLC: SEND ALL CORRESPONDENCE THROUGH THE ARCHITECT

ARCHITECTS, INC.

3801 NORTH 24TH STREET SUITE 100 - LANCE MEINHOLD PHOENIX, ARIZONA 85016 602-955-9929 602-954-4790 FAX EMAIL: Imeinholdalarson-architects.com ZONINGC-2 (C)

1. ALL AIRCRAFT SHALL COMPLY WITH AIRPARK RULES AND REGULATIONS PERTAINING TO AIRCRAFT WINGSPAN RESTRICTIONS AND INDEMNIFICATION. 2. GROUND COVER OR PAVING FOR TAXILANE SAFTEY AREA THAT IS A WEIGHT BEARING SURFACE SHALL NOT INCLUDE ROCKS LESS THAN 2" IN DIAMETER. 3. ALL EXTERIOR LIGHTING SHALL BE DOWNWARD TO PREVENT GLARE TO PILOTS ON SURFACES FACING THE TAXILANE. SEE ADDITIONAL NOTES AN SPIZA PROJECT DATA

BUILDING AREA (UNCHANGED): OFFICE: 2,620 S.F. HANGAR: 7,660 S.F. MEZZANINE: 2,220 S.F. TOTAL: 12,500 S.F. NET LOT AREA: 33,708 S.F. FLOOR AREA RATIO (F.A.R.): 12,500

OTHER AREA (NON-MOVEMENT)

PARKING IS UNCHANGED (CALCULATIONS ARE FOR REFERENCE

ONLY) OFFICE AREA: 2,620 / 300 = 8.7

HANGAR AND SUPPORT AREA: O SPACES REQUIRED

- EXISTING ASPHALT PARKING LOT
- 2) EXISTING SITE SECURITY WALL
- EXISTING DUMPSTER ENCLOSURE
- EXISTING CONCRETE CURB AND
- 5 EXISTING CONCRETE PAVED STAGING AREA WITH LESS THAN 2% SLOPE
- 6) EXISTING TAXI-LANE CENTERLINE
- EXISTING LANDSCAPE AREA
- AREA PER CITY OF SCOTTSDALE MUNICIPAL AIRPORT STANDARDS

GENERAL NOTES:

33,708 = 37.08%

USABLE STAGING AREA: 6,700 S.F.

OPEN SPACE:

ZONING 1-1

ZONING 1-1

HELM DRIVE

9,239

SPACES

TOTAL SPACES REQUIRED = 9 SPACES

SITE PLAN KEYNOTES

Drawing Name:

Larson

AIRPORT DATA SITE PLAN

Revisions


Date: 11/02/18 Project Number:

2016-009 Drawing No:

11/13/2018

SPI



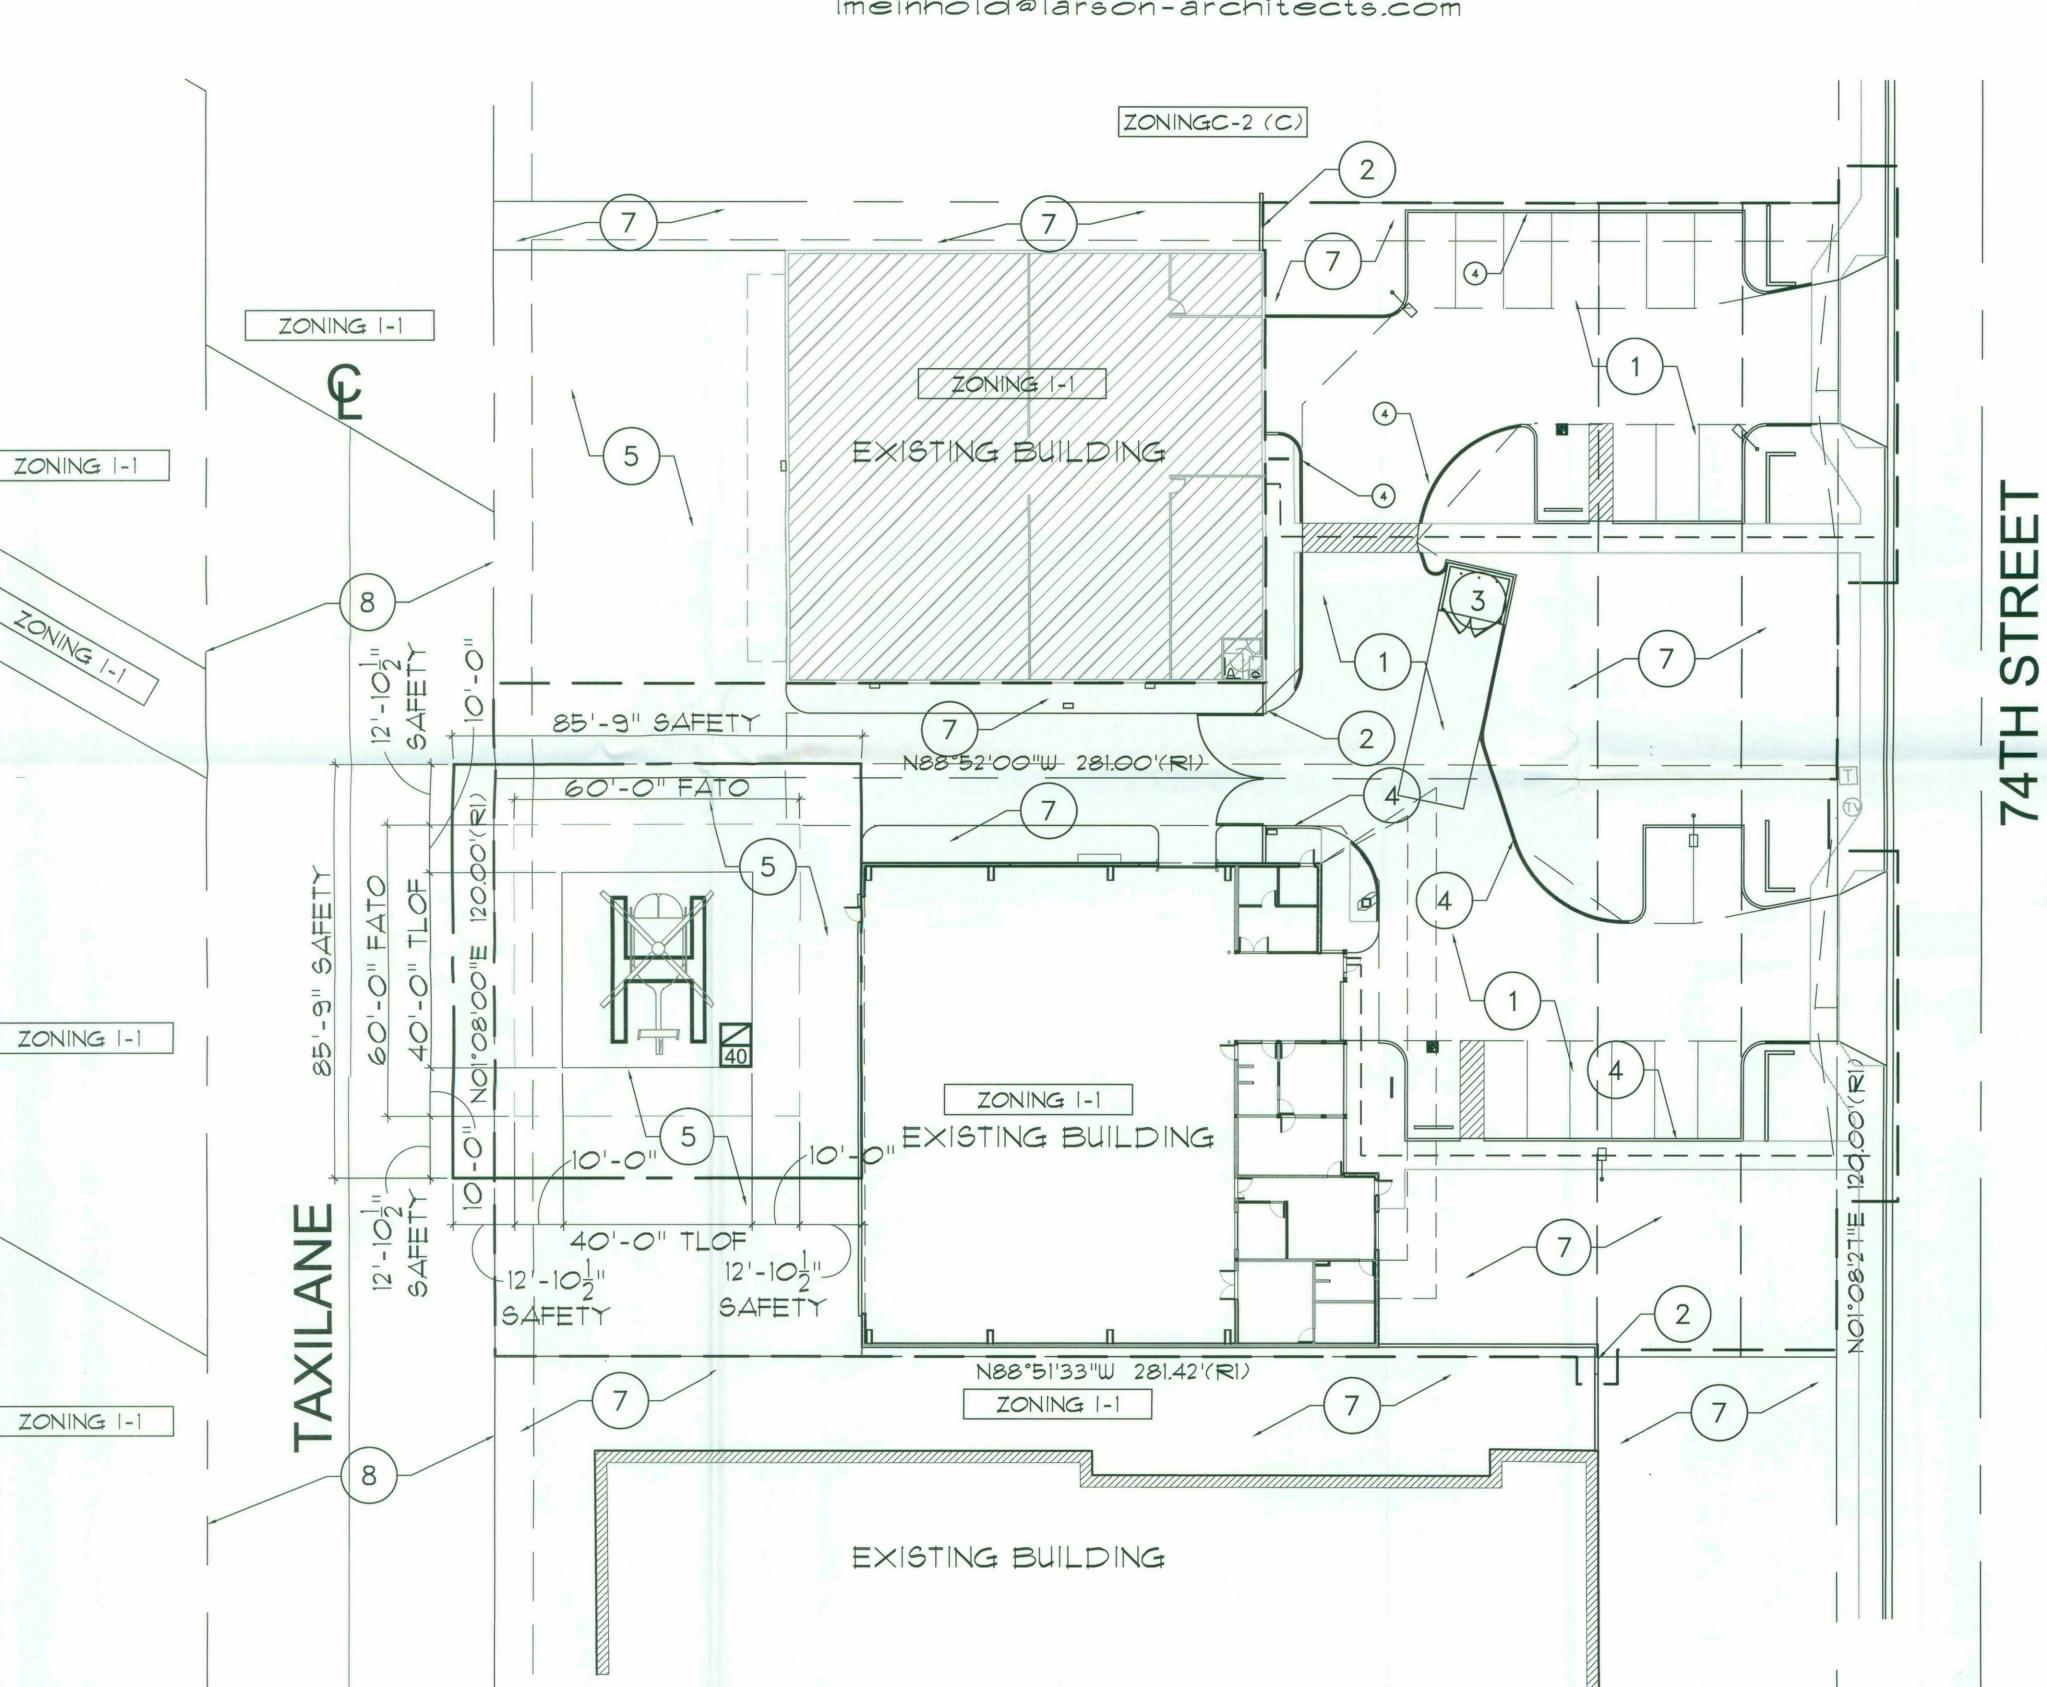

HELIPORT SITE PLAN

SCALE: 1"=20'-0"

HELIPORT SITE PLAN NOTES

NOTES:

1. THE PERIMETER OF THE TLOF AREA SHALL BE MARKED WITH A 12" WIDE CONTINUOUS WHITE PAINTED LINE 2. THE PERIMETER OF THE FATO AREA SHALL BE MARKED WITH A 12" WIDE DASHED LINE CLEARLY INDICATING THE CORNERS OF THE PERIMETER THE PAINTED SEGMENTS OF THE LINE SHALL BE APPROXIMATELY 5' LONG WITH END-TO-END DISTANCE OF APPROXIMATELY 5'

4. THE FAA STANDARD SIZE AND WEIGHT LIMITATIONS BOX SHALL BE PROVIDE IN ACCORDANCE WITH FAA-AC 150/2390-2 FIGURE 2-22, THE 9'-0" x 6'-9" STANDARD WEIGHT AND SIZE LIMITATION BOX SHALL BE PAINTED IN WHITE WITH 5" WIDE LINES. THE BOX SHALL BE DIVIDE INTO TWO SECTIONS (TOP AND BOTTOM) BY A 5" WIDE WHITE LINE, THE TOP SECTION OF THE BOX SHALL HAVE A 5" WIDE WHITE DIAGONAL LINE PAINTED TO INDICATE NO WEIGHT LIMIT, THE BOTTOM SECTION OF THE BOX SHALL HAVE THE NUMBER "40" PAINTED IN 5" WIDE WHITE LINES TO INDICATE THE MAXIMUM ROTOR DIAMETER FOR THE HELI-PAD.

5. THE FAA FORM 1480 HAS BEEN FILED THE STUDY NUMBER ASSIGNED IS TO BE DETERMINED.

REQUIRED SITE PLAN GENERAL NOTES


- SIGHT DISTANCE TRIANGLES SHALL BE SHOWN ON FINAL PLANS FOR DRIVEWAYS FROM COMMERCIAL SITES AND ANY INTERSECTIONS, AREA WITHIN THE SAFETY TRIANGLE IS TO BE CLEAR OF LANDSCAPING, SIGNS, OR OTHER VISIBILITY OBSTRUCTIONS WITH A HEIGHT GREATER THAN 1.5 FEET TREES WITHIN THE SAFETY TRIANGLE SHALL HAVE A CANOPY THAT BEGINS AT 8 FEET IN HEIGHT UPON INSTALATION, ALL HEIGHTS ARE MEASURED FROM NEAREST STREET LINE ELEVATION
- 2. ALL RIGHT-OF-WAY ADJACENT TO THIS PROPERTY SHALL BE LANDSCAPED AND MAINTAINED BY THE PROPERTY OWNER.
- 3. ALL SIGNS REQUIRE SEPERATE PERMITS AND APPROVALS 4. NO EXTERIOR VENDING OR DISPLAY SHALL BE ALLOWED
- 5. FLAG POLES, IF PROVIDED SHALL BE ONE PIECE CONICAL TAPERED. 6. NO EXTERIOR PUBLIC ADDRESS OR SPEAKER SYSTEM SHALL BE

ALLOWED.

- 7. ALL EXTERIOR MECHANICAL, UTILITY, AND COMMUNICATION EQUIPMENT SHALL BE SCREENED TO A HEIGHT OF THE TALLEST UNIT BY PARAPET OR SCREEN WALL THAT MATCHES THE ARCHITECTURAL COLOR AND ARCHITECTURAL FINISH OF THE BUILDING, GROUND MOUNTED MECHANICAL, UTILITY, AND COMMUNICATION EQUIPMENT SHALL BE SCREENED BY A SCREEN WALL THAT MATCHES THE ARCHITECTURAL COLOR AND ARCHITECTURAL FINISH OF THE BUILDING, WHICH IS A MINIMUM OF 1'-0" HIGHER THAN THE HEIGHEST POINT OF TALLEST UNIT.
- 8. ALL EQUIPMENT, UTILITIES, OR OTHER APPURENANCES ATTACHED TO THE BUILDING SHALL BE AN INTEGRAL PART OF THE BUILDING DESIGN IN TERMS OF FORM, COLOR AND TEXTURE.
- 9. NO EXTERIOR VISIBLE LADDERS SHALL BE ALLOWED. 10. ALL POLE MOUNTED LIGHTING SHALL BE A MAXIMUM OF 20 FEET IN HEIGHT.
- 11. NO CHAIN LINK OR DOOLEY WALL FENCING SHALL BE ALLOWED. 12. ALL EXTERIOR CONDUIT AND RACEWAYS SHALL BE PAINTED TO MATCH THE BUILDING 13. UPON REMOVAL OF THE SALVAGEABLE NATIVE PLANTS THE SALVAGE CONTRACTOR SHALL COMPLETE NATIVE PLANT TRACKING FORM AS WELL AS A LIST IDENTIFYING THE TAG NUMBERS OF THE PLANTS SURVIVING SALVAGE OPERATIONS TO THE CITY'S INSPECTION SERVICES UNIT WITHIN 3 MONTHS FROM THE BEGINNING OF SALVAGE OPERATIONS AND/OR PRIOR TO THE ISSUANCE OF THE CERTIFICATE OF OCCUPANCY. 14. ALL EXTERIOR LUMINAIRES SHALL MEET ALL IESNA REQUIREMENTS FOR FULL CUTOFF, AND SHALL BE AIMED DOWNWARD AND AWAY FROM PROPERTY LINES EXCEPT SIGN, PARKING LOT CANOPY AND LANDSCAPE LIGHTING. 15. CITY STAFF MAY AT ANY TIME REQUEST THE DEVELOPER TO SUBMIT AS-BUILT PLANS TO THE INSPECTION SERVICES DIVISION. AS BUILT PLANS SHALL BE CERTIFIED IN WRITING BY A REGISTERED PROFESSIONAL ENGINEER, USING AS-BUILT DATA FROM A REGISTERED LAND SURVEYOR AS-BUILT PLANS FOR DRAINAGE FACILITIES AND STRUCTURES SHALL INCLUDE, BUT ARE NOT LIMITED TO STREETS, LOT GRADING, STORM DRAIN PIPE, VALLEY GUTTERS, CURB AND GUTTER, FLOOD WALLS, CULVERTS, INLET AND OUTLET STRUCTURES, DAMS, BERMS, LINED AND UNLINED OPEN CHANNELS, STORM WATER STORAGE BASINS, UNDERGROUND STORM WATER STORAGE TANKS, AND BRIDGES AS

DETERMINED BY CITY STAFF.

- 16. TEMPORARY/SECURITY FENCING THAT IS REQUIRED OR IS OPTIONAL PROVIDED SHALL BE IN ACCORDANCE WITH THE ZONING ORDINANCE AND THE DESIGN STANDARDS AND POLICIES MANUAL. IT. THE TEMPORARY/SECURITY FENCE LOCATION SHALL NOT BE MODIFIED OR THE TEMPORARY/SECURITY FENCE SHALL NOT BE REMOVED WITHOUT THE APPROVAL OF THE PLANNING AND DEVELOPMENT SERVICES' INSPECTION SERVICES DIVISION. 18. NO TURF AREAS SHALL BE PROVIDED. 19. NO IRRIGATION SHALL BE PROVIDED TO UNDISTURBED NATURAL
- OPEN SPACE (NAOS) AREAS 20. NO HELICOPTER ACCESS OF HELIPORT APPROVED UNDER THIS REVIEW. 21. COORDINATE ALL OFF-SITE
- TRAFFIC CONTROLS WITH THE CITY OF SCOTTSDALE TRAFFIC DEPARTMENT AND ADOT DURING THE CONSTRUCTION PROCESS
- 22. THE FACE OF THE SERVICE ENTRY SECTION SHALL BE FLUSH WITH THE BUILDING FACADE AND PAINTED TO MATCH THE BUILDING.
- 23. ROOF DRAINAGE SYSTEMS SHALL BE INTERIOR.
- 24. NO EXTERIOR VENDING OR DISPLAY SHALL BE ALLOWED. 25. WALL ENCLOSURE FOR REFUSE BE CONSTRUCTED OF MATERIALS, WITH COLORS AND TEXTURES WHICH ARE COMPATIBLE WITH THE BUILDING ON THE SITE
- 26. ALL SITE WALLS SHALL MATCH THE ARCHITECTURAL COLOR. MATERIALS AND FINISH OF THE BUILDING.
- 27. THE MAXIMUM HEIGHT FROM FINISH GRADE TO THE BOTTOM OF ANY EXTERIOR LUMINAIRE SHALL NOT EXCEED TWENTY (20) FEET. 28. ALL LUMINAIRES SHALL BE RECESSED OR SHIELDED SO THE LIGHT SOURCE IS NOT DIRECTLY VISIBLE FROM THE PROPERTY LINE.

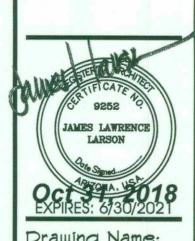

Drawing Name NATURAL AREA OPEN SPACE NOTES

Revisions

11/02/18 0

Project Number: 2016-009 Drawing No:

11/13/2018

SCOTTSDALE, ARIZONA 85260

OWNER

ZONING 1-1

ZONING 1-1

ZONING 1-1

TRIPLE C AIRPARK PROPERTIES LLC; SEND ALL CORRESPONDENCE THROUGH THE ARCHITECT

ZONING 1-1

N

85'-9" SAFETY

60'-0" FATO

40'-0" TLOF

12'-105

SAFETY

HELIPORT SITE PLAN

SCALE: 1"=20'-0"

TRIPLE C HANGAR LARSON ASSOCIATES ARCHITECTS, INC.

EXISTING BUILDING

N88"52'00"W 281.00'(R)

ZONING 1-1

EXISTING BUILDING

ZONING 1-1

EXISTING BUILDING

201

N88°51'33"W 281.42'(R1)

NORTH

3801 NORTH 24TH STREET SUITE 100 - LANCE MEINHOLD PHOENIX, ARIZONA 85016 602-955-9929 602-954-4790 FAX EMAIL:

GENERAL NOTES: 1. ALL AIRCRAFT SHALL COMPLY WITH AIRPARK RULES AND REGULATIONS PERTAINING TO AIRCRAFT WINGSPAN RESTRICTIONS AND INDEMNIFICATION 2. GROUND COVER OR PAVING FOR TAXILANE SAFTEY AREA THAT IS A WEIGHT BEARING SURFACE SHALL NOT INCLUDE ROCKS LESS THAN 2" IN DIAMETER. lmeinholdalarson-architects.com 3. ALL EXTERIOR LIGHTING SHALL BE DOWNWARD TO PREVENT GLARE TO PILOTS ON SURFACES FACING THE TAXILANE. ZONINGC-2 (C) SEE ADDITIONAL NOTES AN SP1.2A PROJECT DATA BUILDING AREA (UNCHANGED): ZONINGI

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OFFICE: 2,620 S.F. HANGAR: 7,660 S.F. MEZZANINE: 2,220 S.F. TOTAL: 12,500 S.F. NET LOT AREA: 33,708 S.F. FLOOR AREA RATIO (F.A.R.): 12,500 / 33,708 = 37.08%

USABLE STAGING AREA: 6,700 S.F.

OTHER AREA (NON-MOVEMENT)

OPEN SPACE:

ZONING 1-1

ZONING 1-1

HELM DRIVE

PARKING IS UNCHANGED (CALCULATIONS ARE FOR REFERENCE ONLY)

OFFICE AREA: 2,620 / 300 = 8.7 SPACES

HANGAR AND SUPPORT AREA: O SPACES REQUIRED TOTAL SPACES REQUIRED = 9 SPACES

SITE PLAN KEYNOTES

EXISTING ASPHALT PARKING LOT

2) EXISTING SITE SECURITY WALL

3 EXISTING DUMPSTER ENCLOSURE

4) EXISTING CONCRETE CURB AND

5) EXISTING CONCRETE PAVED STAGING AREA WITH LESS THAN 2% SLOPE

EXISTING TAXI-LANE CENTERLINE

EXISTING LANDSCAPE AREA

AREA PER CITY OF SCOTTSDALE MUNICIPAL AIRPORT STANDARDS



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Drawing Name NATURAL AREA OPEN SPACE PLAN

Revisions

11/02/18

Project Number: 2016-009

Drawing No:

SP1.2 11/13/2018



14818 N. TATH STREET

OWNER

SCOTTSDALE, ARIZONA 85260

THROUGH THE ARCHITECT

TRIPLE C AIRPARK PROPERTIES

LLC; SEND ALL CORRESPONDENCE

SCALE: 1"=20'-0" 0 10'

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1,620 S.F. 962 S.F. ,716 S.F. 245 S.F. 9,343 S.F. EXISTING BUILDING 4,197 S.F. 454 S.F. C 593 S.F 590 S.F. 18 S.F. 726 S.F. 6,865 S.F 461 S.F. 9,239 S.F. 4,381 S.F. 403 S.F. EXISTING BUILDING OPEN SPACE PLAN

NORTH

INTERIOR PARKING LOT LANDSCAPING REQUIRED (PARKING LOT LANDSCAPE REQUIRED)x.33: $= 1.401.45 \times .33 = 462.48 \text{ S.F.}$ INTERIOR PARKING LOT LANDSCAPE PROVIDED: 593 S.F. = OK OPEN FRONT SPACE REQUIRED: $= 35 \times 119.92 = 4,197.20$ S.F. OPEN FRONT SPACE PROVIDED 4,442 S.F. = OK STAGING AREA: USEABLE: OPEN SPACE: +++++ SIDE OPEN SPACE (NOT INCLUDED ABOVE) 2,210 S.F. REQUIRED OPEN SPACE: MAXIMUM BUILDING HEIGHT = 36'-0" PROVIDED: 36'-0" FIRST 12'-O" OF HEIGHT (10% X NET LOT AREA) = 10x33,699=3,369,90 S.F. NEXT 24'-0" OF HEIGHT = 24.833x.004x33,699 = 3,347,39 S.F. OPEN SPACE REQUIRED (NOT INCLUDING PARKING LOT LANDSCAPING) = 3,369.90 + 3,347.39 = 6,717.29 STAGING AREA REDUCTION: REDUCED OPEN SPACE REQUIRED: TOTAL REQUIRED = 5,378.58 S.F. OPEN SPACE PROVIDED = 13,368 S.F. = OK

OPEN SPACE CALCULATIONS (SOUTH PROPERTY)

= 6,717.29((33,699-6,716)/33,699) = 5,378.58 S.F.

4,646 S.F.

6,716 S.F.

PARKING LOT PAYED AREA: 6,865 S.F. PARKING LOT LANDSCAPING REQUIRED (PARKING LOT AREA × 15%) = 6,865×.15 = 1,029.75 S.F PARKING LOT LANDSCAPE PROVIDED:

1,472 S.F. = OK INTERIOR PARKING LOT LANDSCAPING REQUIRED (PARKING LOT LANDSCAPE REQUIRED)x.33:

 $= 1.029.75 \times .33 = 339.82 \text{ S.F.}$ INTERIOR PARKING LOT LANDSCAPE PROVIDED: 763 S.F. = OK

OPEN FRONT SPACE REQUIRED: $= 35 \times 119.92 = 4,197.20$ S.F. OPEN FRONT SPACE PROVIDED

4,381 S.F. = OK STAGING AREA:

> USEABLE: 6,700 S.F. OPEN SPACE: 9,239 S.F.

SIDE OPEN SPACE (NOT INCLUDED ABOVE) 665 S.F.

REQUIRED OPEN SPACE: MAXIMUM BUILDING HEIGHT = 36'-0"

PROVIDED: 36'-0" FIRST 12'-O" OF HEIGHT

 $(10\% \times NET LOT AREA) = .10x33,708 = 3,370.80 S.F.$ NEXT 24'-0" OF HEIGHT = 24.833x.004x33,708 = 3,348.28 S.F.

OPEN SPACE REQUIRED

(NOT INCLUDING PARKING LOT LANDSCAPING) = 3,370.80 + 3,348.28 = 6,719.08

STAGING AREA REDUCTION: REDUCED OPEN SPACE REQUIRED:

= 6,119.08((33,108-9,239)/33,108) = 4,811.45 S.F.

TOTAL REQUIRED = 4,877.45 S.F. OPEN SPACE PROVIDED = 14,285 S.F. = OK

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HELIPORT SITE PLAN NOTES


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5. THE FAA FORM 1480 HAS BEEN FILED THE STUDY NUMBER ASSIGNED IS TO BE DETERMINED.

Larson



Revisions

11/02/18 Project Number: 2016-009

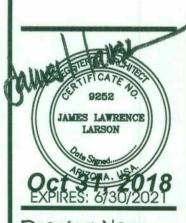Drawing No:

SPI

11/13/2018

Drawing Name NATURAL AREA OPEN SPACE NOTE

Revisions

THE BUILDING OR TO THE EXTERIOR OF THE

BUILDING AS A PART OF THE HELIPORT USE

2. ALL CONDITIONS INSIDE THE BUILDING

PERMIT PROCESS.


NORTH

ARE EXISTING TO REMAIN.

Date:

Project Number: 2016-009 Drawing No:

18-UP-2018 11/13/2018

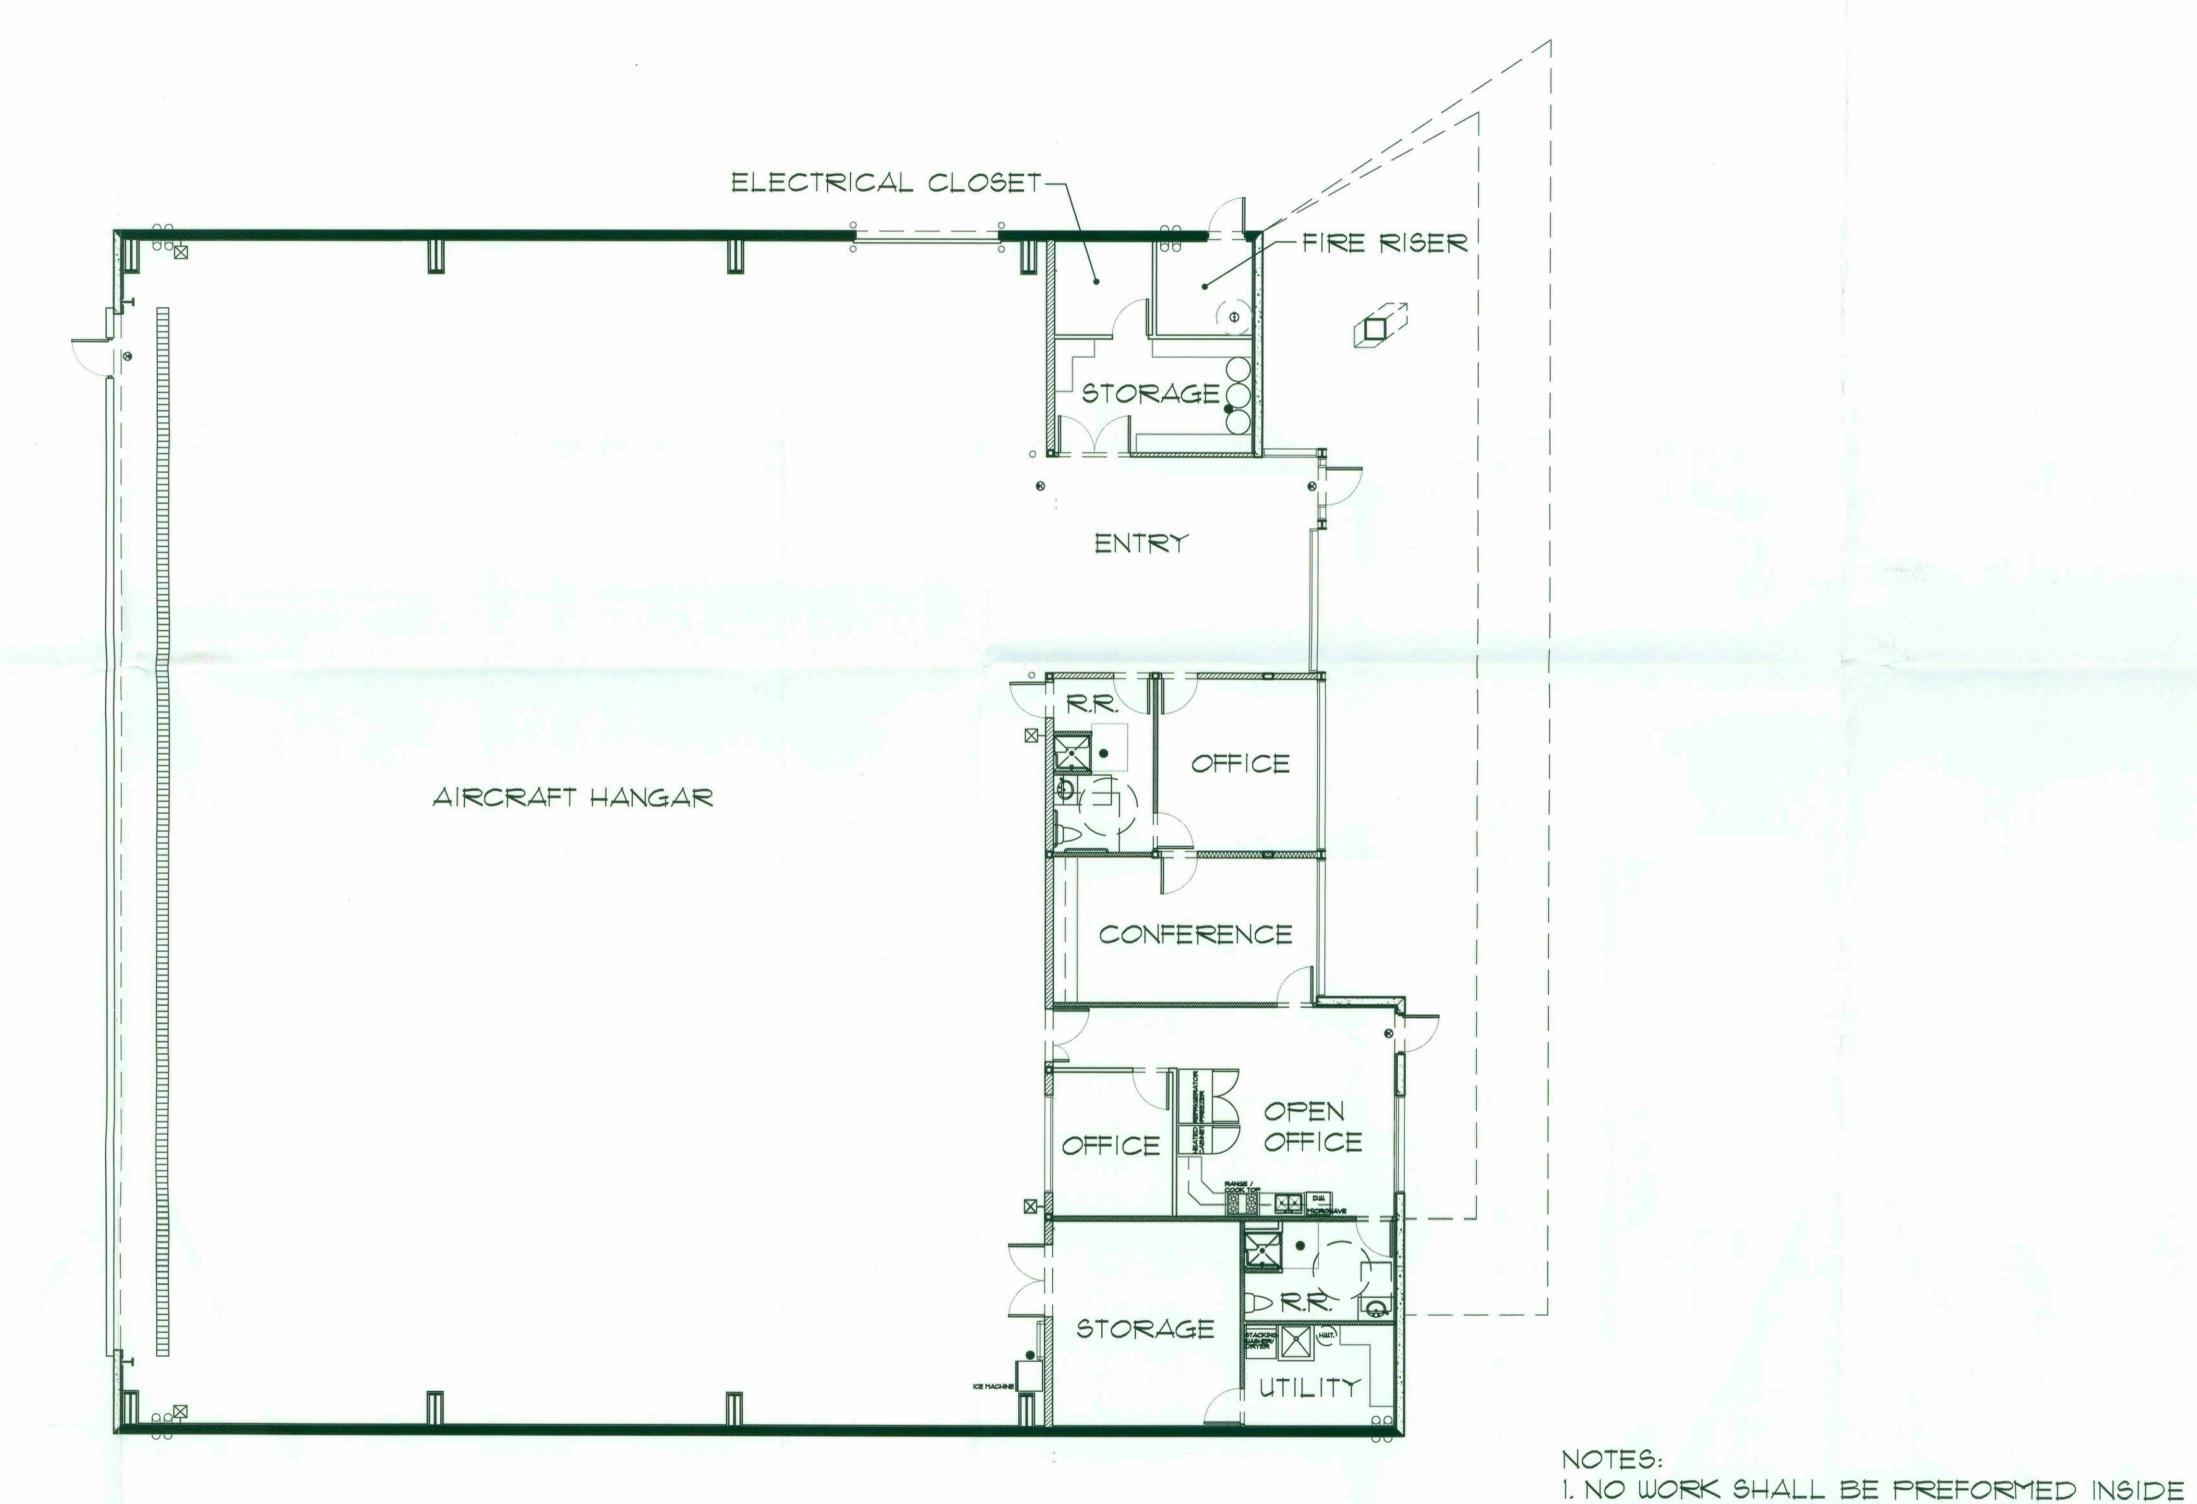

FLOOR PLAN

SCALE: 1/8"=1'-0" 0 4'